

Public Notice Details

Planning Application Details

Application No	DA2500038
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Property Details

Property Location	6 Rekuna Station Road Campania
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Application Information

Application Type	Discretionary Development Application
Development Category	Outbuilding
Advertising Commencement Date	2/4/2025
Advertising Closing Period	16/4/2025
If the Council Offices are closed during normal office hours within the above period, the period for making representations is extended.	

Enquiries regarding this Application can be made via to Southern Midlands Council on (03) 6254 5050 or by emailing <u>planningenquires@southernmidlands.tas.gov.au</u>. Please quote the <u>development application number</u> when making your enquiry.

Representations on this application may be made to the General Manager in writing either by

Post: PO Box 21, Oatlands Tas 7120 Email: mail@southernmidlands.tas.gov.au

Fax: 03 6254 5014

All representations must include the authors full name, contact number and postal address and be received by the advertising closing date.





APPLICATION FOR PLANNING PERMIT DEVELOPMENT / USE

Use this form to apply for a permit in accordance with section 57 and 58 of the Land Use Planning and Approvals Act 1993

Proposed use/development: (Provide details of proposed works and use).	Erecting a shed on property for personal	storage use
Location of Development: (If the development includes more than one site, or is over another property include address of both Properties).	6 Rekuna Station Road, Campania	
Certificate of Title/s Volume Number/Lot Number:		
Land Owners Name:		
Land Owners Name.	Megan Ann Lee & Mathew Thomas Lee Full Name/s or Full Business/Company Name	
	ruii Name/s or Full Business/Company Name	
Applicant's Name:	Megan Ann Lee & Mathew Thomas Lee	
	Full Name/s or Full Business/ Company Name (ABN if registered but	usiness or company name)
Contact details:	Postal address for correspondence: Po Box, 190 Camp	ania
	Telephone or Mobile: 0400630176	
	Email address: meg27_@hotmail.com	
	(Please note it is your responsibility to provide your correct email address and it	to check your email for communications from the Council \
	The lease had the year responsibility to provide year contest circuit address and t	o oncor your ornain or communications with the countries
Details		
Tax Invoice for application fees to be	Full Name/s or Full Business or Company Name and ABN if reg	sistered business or company name
in the name of: (if different from applicant)	Print email address	ABN
. ,		
	What is the estimated value of all the new work proposed	
	\$ 20,000.00	





For Commercial Planning Permit Applications Only

Signage:	Is any signage	proposed?						Yes	No	
	If yes, attach deta	ails: size, location a	and art wor	rk						
	Existing hours o	f operation				Proposed hours	s of new oper	ation		
Business Details:	Hours	am	to	pm		Hours	am	to	pm	
	Weekdays				-	Weekdays				
	Sat					Sat				
	Sun					Sun				
Number of existing employees:			١	Number of	proposed	new employees:				
Traffic Movements:	Number of con vehicles servin present					Approximate n commercial ve servicing the s future	hicles			
Number of Car Parking Spaces:	How many car currently provide					How many nev are proposed	w car spaces			
Is the development to be staged: Please attach any a Scheme – Southern		No No ation that may	/ be requ	uired by	Part 6.1 /	Application Req	uirements c	of the Tas	smanian Pl	anning
Signed Declaration										
I/we as owner of the	e land or perso	n with conse	nt of the	e owner	hereby d	eclare that:				
	ead the Certifica ed by any restric					or the land and I	/we are sati	sfied that	this applica	ation is
2. I/we provide	e permission by	or on behalf o	f the app	olicant for	· Council o	officers to enter	the site to a	ssess the	e applicatio	n.
with this ap	ation given in thi plication may be and materials a	e made availat	ole to the	e public.	I/we unde	erstand that the	Council ma	y make s	such copies	
with the app	ecured the nece olication for asse breach of copy	essment. I/we	indemni	fy the So	uthern Mi	dlands Council	for any clair			
the owner of Crown, the	e that, in accord of the intention t ir consent is att anager of the Co	to make this a ached and the	pplicatio	n. Where	e the subj	ject property is	owned or co	ontrolled	by Council	or the
Applicant Signatur (If not the Title Owner			Appl	icant Nam	e (please j	orint)			Date	
Land Owner(s) Sign	ature		Land	Owners A	lame (plea	se print)			Date	
1000	`		Ī	Megan I	ee			12/3/2	25	





Land Owner(s) Signature	Land Owners Name (please print)	Date
mle	Mathew Lee	12/3/25

PRIVACY STATEMENT

The Southern Midlands Council abides by the Personal Information Protection Act 2004 and views the protection of your privacy as an integral part of its commitment towards complete accountability and integrity in all its activities and programs.

Collection of Personal Information: The personal information being collected from you for the purposes of the Personal Information Protection Act, 2004 and will be used solely by Council in accordance with its Privacy Policy. Council is collecting this information from you in order to process your application.

Disclosure of Personal Information: Council will take all necessary measures to prevent unauthorised access to or disclosure of your personal information. External organisations to whom this personal information will be disclosed as required under the Building Act 2000. This information will not be disclosed to any other external agencies unless required or authorised by law.

Correction of Personal Information: If you wish to alter any personal information you have supplied to Council please telephone the Southern Midlands Council on (03) 62545050. Please contact the Council's Privacy Officer on (03) 6254 5000 if you have any other enquires concerning Council's privacy procedures.



DESIGN DETAILS						
TITLE REFERENCE						
VOLUME/CERTIFICATE FOLIO	1 / 155416					
PID	2941277					
FLOOR AREAS	•					
EXISTING SITE AREA	12660	m ²				
EXISTING GROUND FLOOR	NIL	m ²				
PROPOSED GROUND FLOOR	72	m ²				
PROPOSED TOTAL GROUND FLOOR	72	m ²				
		•				
DESIGN WIND CLASSIFICATION	N2					
SOIL CLASSIFICATION	M	<u> </u>				
CLIMATE ZONE	7					
BAL RATING	12.5					
ALPINE AREA	NA					
CORROSION ENVIRONMENT	LOW					
OTHER HAZARDS	NA					

DRAWING SCHEDULE — ARCHITECTURAL										
DRAWING NUMBER	TITLE									
A00	Cover Sheet & Location Plan	-								
A01	Site Plan 1:1000	-								
A02	Site Plan 1:500									

DRAWING SCHEDULE — ENGINEERING													
PROPRIETARY SHED	٠	٠	٠	٠	٠	٠	٠	٠	٠	٠	٠		
DRAWING NUMBER	TITLE												
1	SCHEDULE												
2	ELEVATIONS												
3	ELEVATIONS												
4	FLOOR PLAN + ROOF FRAMING												
5	DETAILS												
6	SECTION												



DATE

00 LOCATION PLAN
A00 NOT TO SCALE

RAD LUTRUWITA/TASMANIA

rowbottomarchitecture@gmail.com - 0439 849 433

PROJECT
PROPOSED SHED
6 REKUNA STATION ROAD
CAMPANIA , TAS, AUS
CLIENT
MEGAN & MATT

COVER PAGE & LOCATION PLAN - PROPOSED SHED

DRAWING No.	A00	REVISION No.
1	DATE	02/03/2025
	SCALE	N.A
	PROJECT CODE	2501
	APPROVAL	DEVELOPMENT APPLICATION
Figured dimensions Report any discrept	take precedence to s ncies to the Architect	cale readings. Verify all dimensions on site for decision before proceeding with the work.
0 1	3 [5] 7MI



GENERAL NOTES

BUILDING CLASS: 10A

DO NOT SCALE. ALL DIMENSIONS ARE NOMINAL ONLY. DIMENSIONS ARE TO FINISHED SURFACES UNLESS OTHERWISE NOTED. DIMENSIONS IN MILLIMETRES UNLESS OTHERWISE NOTED. VERIFY ALL DIMENSIONS ON SITE BEFORE COMMENCEMENT OF WORK WITH THE ARCHITECT.



01 SITE PLAN 1:1000

> RAD LUTRUWITA/TASMANIA

rowbottomarchitecture@gmail.com - 0439 849 433

PROJECT
PROPOSED SHED
6 REKUNA STATION ROAD
CAMPANIA , TAS, AUS
CLIENT
MEGAN & MATT

SITE PLAN - PROPOSED SHED

REV. No. DESCRIPTION

DATE

DRAWING No.	A01	REVISION No.
	DATE	02/03/2025
	SCALE	1:1000
	PROJECT CODE	2501
	APPROVAL	DEVELOPMENT APPLICATION
Figured dimensions Report any discrept	take precedence to s ancies to the Architect	cale readings. Verify all dimensions on site for decision before proceeding with the work
0 1	3 [5 7M

GENERAL NOTES

BUILDING CLASS: 10A

DO NOT SCALE. ALL DIMENSIONS ARE NOMINAL ONLY. DIMENSIONS ARE TO EINISHED SURFACES UNLESS OTHERWISE NOTED. DIMENSIONS IN MILLIMETRES UNLESS OTHERWISE NOTED. VERIFY ALL DIMENSIONS ON SUIT BEFORE COMMENCEMENT OF WORK WITH THE ARCHITECT.

NEW 10,000L TANK. ALL STORMWATER FROM PROPOSED ROOFED AREA OF SHED TO BE CAPTURED VIA EAVES GUTTER. REFER ENGINEERING DOCUMENTATION.



SITE PLAN 1:500

> RAD LUTRUWITA/TASMANIA

rowbottomarchitecture@gmail.com - 0439 849 433

PROPOSED SHED 6 REKUNA STATION ROAD CAMPANIA , TAS, AUS CLIENT MEGAN & MATT

SITE PLAN — PROPOSED SHED

REV. No. DESCRIPTION

DRAWING No.	A02	REVISION No.	-
	DATE	02/03/2025	
	SCALE	1:500	
	PROJECT CODE	2501	
	APPROVAL	DEVELOPMENT APPLICATION	1
Figured dimensions Report any discrept	take precedence to s uncles to the Architect	scale readings. Verify all dimensions on for decision before proceeding with the	site
n 1	3 🗆	5]	7M

DATE



ENGINEERING SCHEDULE

CERTIFIED STEEL PORTAL FRAME SHED DESIGN IN ACCORDANCE WITH NCC 2022 FOR SITE WIND SPEED "42,75m/s", WIND REGION "A4". TERRAIN CATEGORY "2". IMPORTANCE LEVEL "2"

Internal Pressure: 0.5

Design Snow Load: 0.00 KPa, Roof Snow Load: 0.00 KPa

Customer: Mathew Lee

Site Address: 6 Rekuna Station Road, Campania TAS 7016

Main Building: Span: 6, Length: 12, Height: 3, Roof Pitch: 11 degrees The length being comprised of 4 bays, the largest bay is 3.3m bays. Left LeanTo: NA Right LeanTo: NA

Total Kit Weight: 1725.09kg

INTERNAL PORTALS

Column: C15015 Rafter: C15015 Knee Brace: NA Knee Brace Length: NA Apex Brace: C15015

Apex Brace Length: 3700

END PORTALS

Column: C15015 Rafter: C15015 Knee Brace: NA Knee Brace Length: NA Apex Brace: NA Apex Brace Length: NA Endwall Mullion: C15015

LEFT LEAN TO PORTALS

Internal Column: NA Internal Rafter: NA End Column: NA Fnd Rafter: NA Knee Brace: NA Knee Brace Length: NA RIGHT LEAN TO PORTALS

Internal Column: NA Internal Rafter: NA End Column: NA End Rafter: NA Knee Brace: NA Knee Brace Length: NA

NOTE: All unclad intermediate columns are always back to back (refer to drawing: Floor Plan).

I	PURLINS AND GIRTS				
I	Eave Purlin: C10010				
I	Side Wall Girts: TH64075	Max Spacing: 1250	Overlap: 10%		
I	Front End Wall Girts: TH64075	Max Spacing: 1250	Overlap: 10%		
I	Back End Wall Girts: TH64075	Max Spacing: 1250	Overlap: 10%		
I	Roof Purlins: TH64075	Max Spacing: 1000	Overlap: 10%		

NOTE: Girt spacing will vary to a maximum 1.25m where window/s are located.

FASTENERS

Sleeve Anchor Bolts: M12x80 Sleeve Anchor Yellow Zinc Frame Bolts: M12x30 Purlin Assembly Zinc (Mild) Frame Screws: Frame Screw 14x14x22

Cross Bracing Strap: 32mm x 1.2 strap

Open Bay Header Height: 300

COLOUR SCHEDULE

Roof Sheets: Mist Green External Wall Sheets: Mist Green Roller Doors: Mist Green Flashings: Mist Green PA Doors: Mist Green Windows: NA

<u>DOMESTIC & LIGHT INDUSTRIAL STEEL PORTAL</u> FRAME SHED STRUCTURES

This structure is designed in compliance with AS4600, AS3600 and AS1170 1 to 4 as Importance Level 2 with a Live Load of 0.25kPa as "Air Leaky Structures" providing stability when openings are prevalent.

The structures are clad with corrugated pre-painted finish, 0.42mm walls and 0.42mm roof (compliant with AS1562.1 Metal) over cold formed 450 to 550mPa galvanized steel C sections primary frames.

Primary framing is fastened together with 4.6 Class galvanized bolts adequately tensioned on ground prior to erection.

Secondary framing steel bracing, with purlins and girts lapped, are all tek fastened to primary steel with a minimum of two (2) teks per connection as specified in details.

All rainwater products are compliant with AS2179.1 (Metal).

ENGINEERING

The undersigning engineer has checked that the design of the structure complies with relevant current Australian Standards as stated above and the following i.e AS4671- 2001 Steel Reinforcing materials, AS3600 - Concrete structures. However, he will not be present during construction, neither will be conduct inspections nor construction supervision.

The class 10a buildings are designed for erection on pad footings or slab based on soil of classification "A"-"P" with minimum bearing capacity 100kPa (i.e. organic soil is to be removed to a suitable material below natural surface).

Where (suitable) fill is required to level the site, it should be placed and compacted in layers of 150mm maximum.

Concrete pad footings and slab supply and placement is to be in compliance with AS2870-2011 Residential Slabs & Footings, AS3600-2009 Concrete Structures for A2 and B2 exposure (i.e. 25mPa strength @ 28 days strength) with recommended slump 75 to 80mm for light pneumatic tyred traffic all trafficable floors.

25mm deep concrete saw cut, to be made into the surface of the concrete slab every 6m in width or length as crack control joints.

For sites where these conditions are considered to be inadequate, a customized foundation design for the structure can be supplied to suit a specific purpose.

CONSTRUCTION

Erection of the structure is to be in compliance with local and state ordinances,

Occupational Health and Safety Regulations and with plans provided.


GENERAL

The designs as portrayed on the drawings remain the intellectual property of Best Sheds Pty Ltd and are provided for building approval and construction purposes only.

SNOW LOAD

Following conditions only apply to buildings with snow loading:

No maintenance or roof traffic permitted on the roof while there is snow present. No other structure to be erected within 500mm of the gutters of this building.

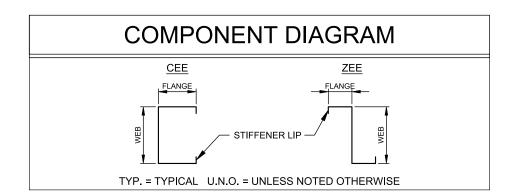

Value & Zuality Direct to You Email: sales@bestsheds.com.au

151 Smeaton Grange Road, Smeaton Grange, NSW, 2567 Phone: 02 4648 7777 Fax: 02 4648 7700



CIVIL & STRUCTURAL ENGINEERS

COMMERCIAL - INDUSTRIAL - RESIDENTIAL - FORENSIC - STEEL DETAILING


CAMILO PINEDA MORENO


Signature: 08.08.2024

Customer Name: Mathew Lee Site Address: 6 Rekuna Station Road Campania TAS, 7016

08-08-2024 DATE JOB NO. 2896479874

SHEET 1 of 6

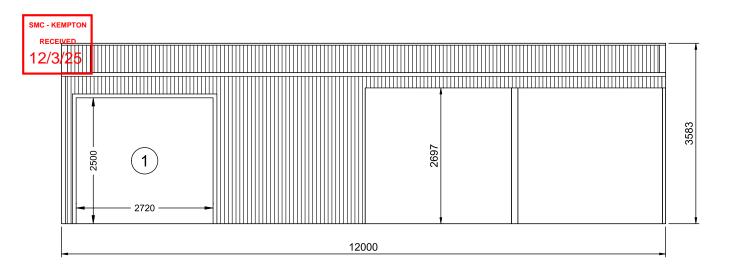

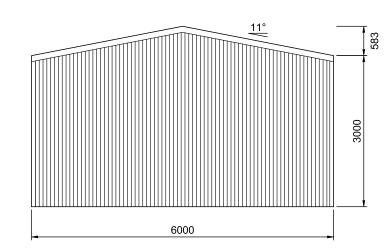

LEFT ELEVATION


SCALE: 1:75

12000

REAR ELEVATION

SCALE: 1:75

FRAME #5

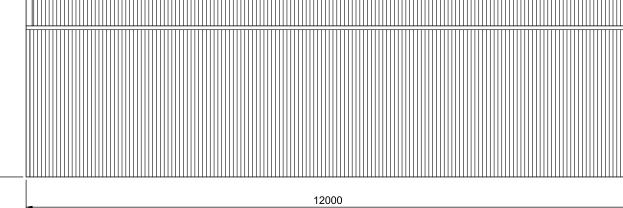

6000

RIGHT ELEVATION

SCALE: 1:75

FRONT ELEVATION

SCALE: 1:75

FRAME #1

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CIVIL & STRUCTURAL ENGINEERS


COMMERCIAL - INDUSTRIAL - RESIDENTIAL - FORENSIC - STEEL DETAILING

CAMILO PINEDA MORENO




Customer Name: Mathew Lee Site Address: 6 Rekuna Station Road Campania, TAS, 7016

DATE 08-08-2024 JOB NO. 2896479874 SHEET 2 of 6

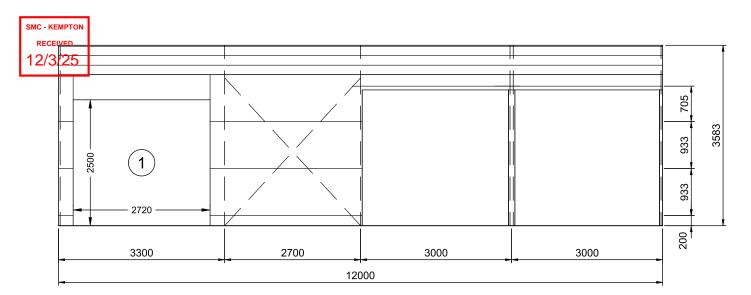

LEFT ELEVATION

SCALE: 1:75

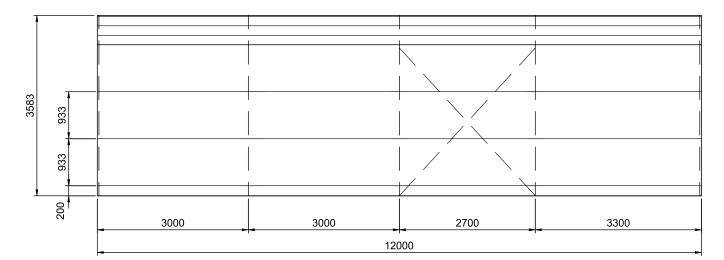

RIGHT ELEVATION


SCALE: 1:75

6000

REAR ELEVATION

SCALE: 1:75

FRAME #5

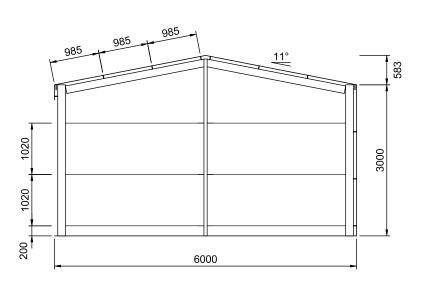

FRONT ELEVATION

SCALE: 1:75

FRAME #1

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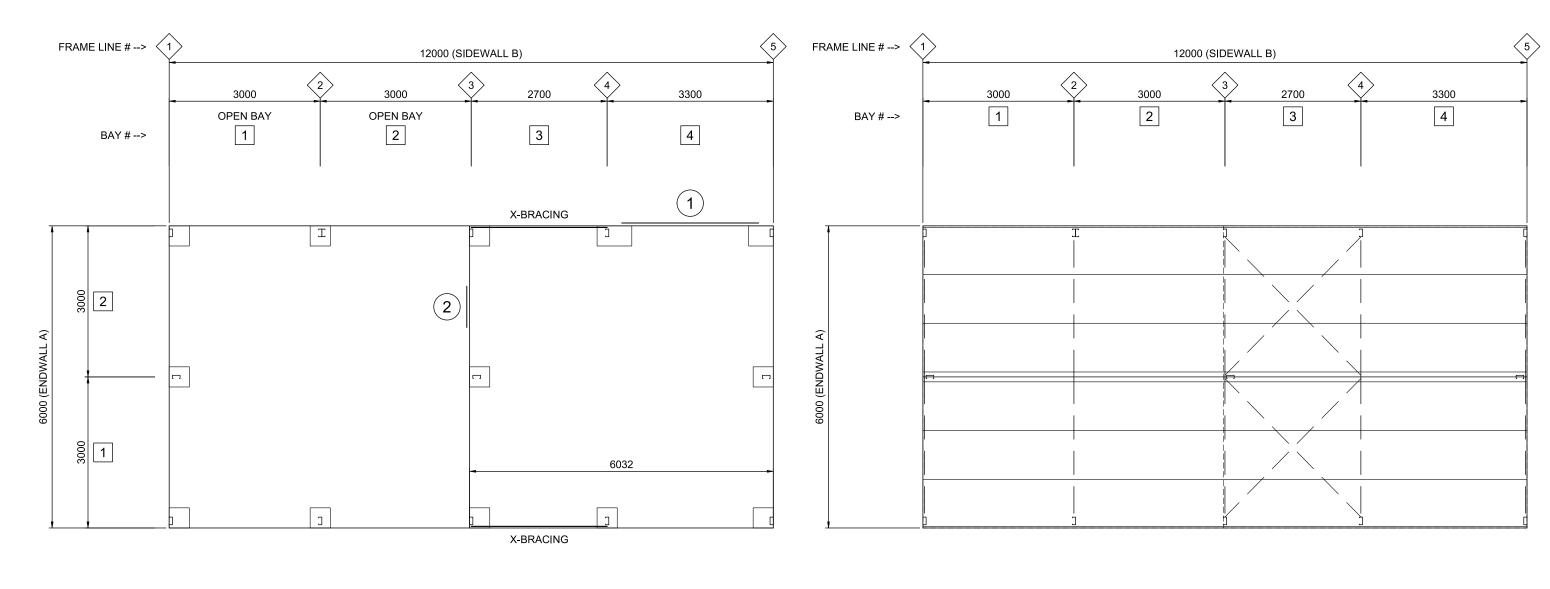
CAMILO PINEDA MORENO



Customer Name: Mathew Lee Site Address: 6 Rekuna Station Road Campania, TAS, 7016

DATE 08-08-2024 JOB NO. 2896479874 SHEET 3 of 6





FLOOR PLAN SCALE: 1:75

ROOF FRAMING PLAN


SCALE: 1:75



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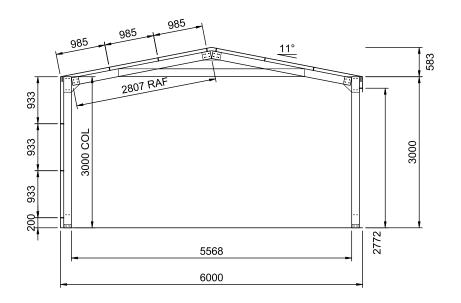
COMMERCIAL - INDUSTRIAL - RESIDENTIAL - FORENSIC - STEEL DETAILING

CAMILO PINEDA MORENO

Customer Name: Mathew Lee Site Address: 6 Rekuna Station Road Campania, TAS, 7016

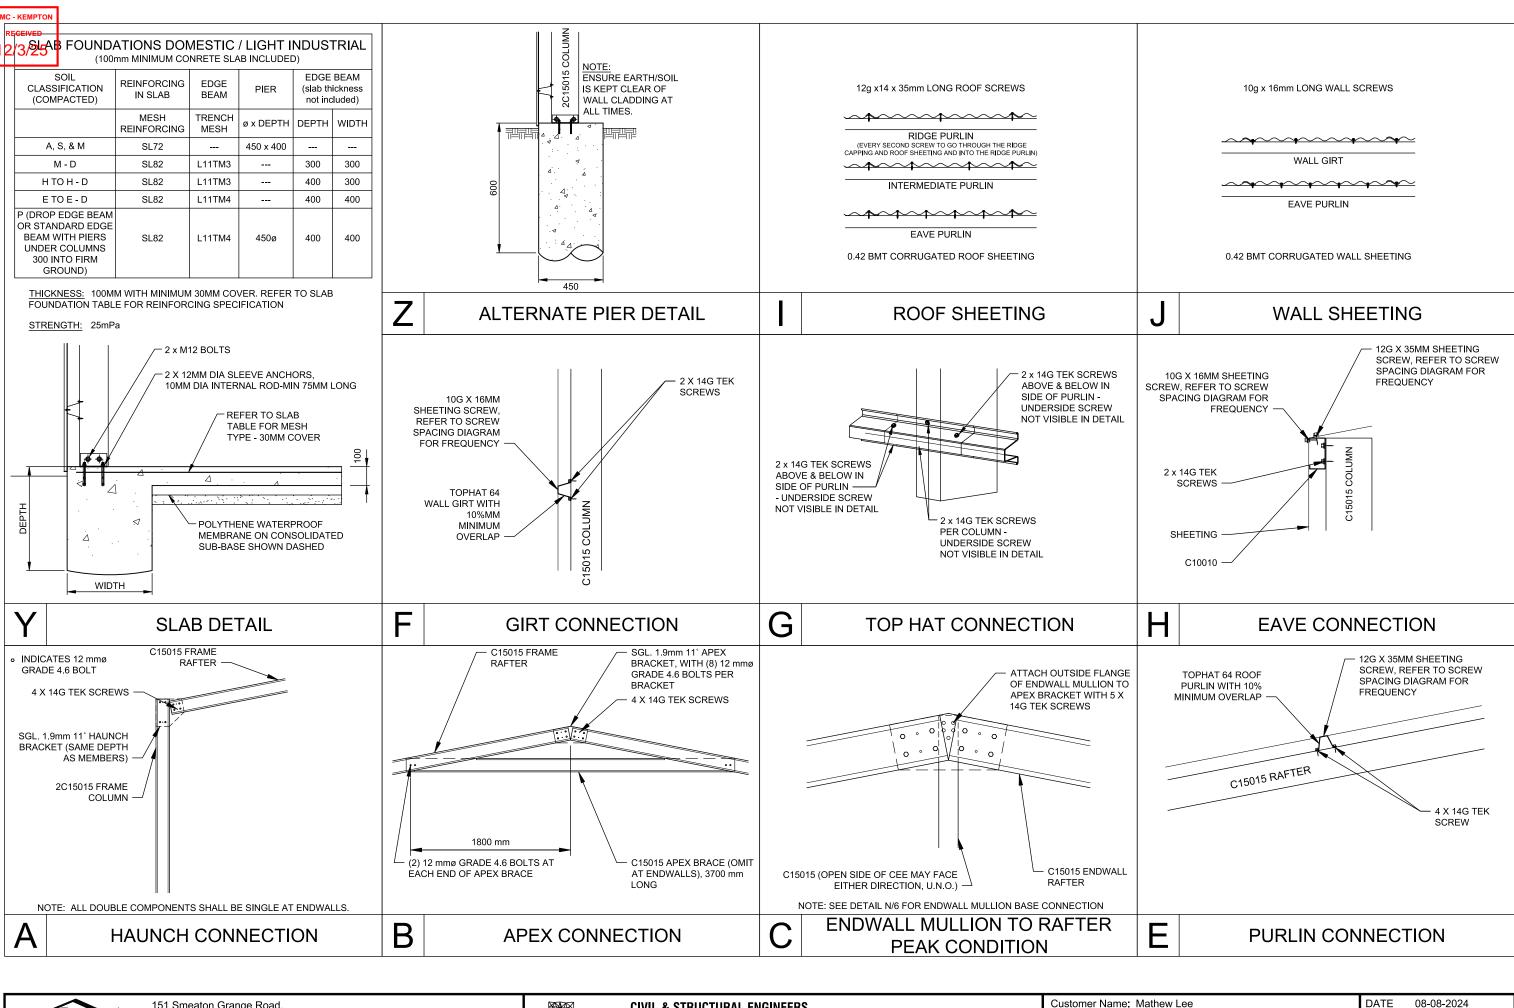JOB NO. 2896479874 SHEET 5 of 6






TYP. FRAME CROSS-SECTION

SCALE: 1:75


FRAMES 2, 4

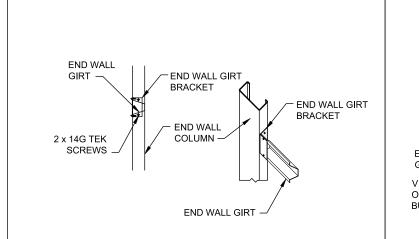


ROLLER DOOR COLUMN 'Z SECTION' END WALL GIRT BRACKET END WALL END WALL **GIRT** VIEW FROM VIEW FROM DOOR OUTSIDE INSIDE BUILDING BUILDING

0 **ENDWALL GIRT BRACKET** SIDE DOOR HEADER AND JAMB


P

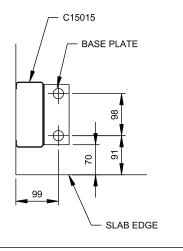

CORNER COLUMN BASE

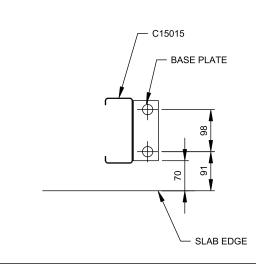

INTERNAL COLUMN BASE

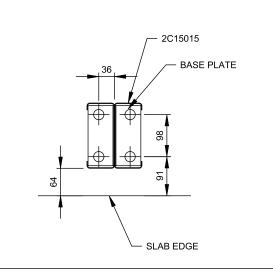

INTERNAL COLUMN BASE

BASE PLATE - C15015 SLAB EDGE

N

ENDWALL MULLION BASE



K

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CIVIL & STRUCTURAL ENGINEERS

COMMERCIAL - INDUSTRIAL - RESIDENTIAL - FORENSIC - STEEL DETAILING

CAMILO PINEDA MORENO

M



Customer Name: Mathew Lee Site Address: 6 Rekuna Station Road Campania, TAS, 7016

DATE 08-08-2024 JOB NO. 2896479874 SHEET 6 of 6



RESULT OF SEARCH

RECORDER OF TITLES

Issued Pursuant to the Land Titles Act 1980



SEARCH OF TORRENS TITLE

VOLUME	FOLIO
155146	1
EDITION 4	DATE OF ISSUE 15-Jun-2024

SEARCH DATE : 22-Jul-2024 SEARCH TIME : 02.48 PM

DESCRIPTION OF LAND

Parish of STAFFA Land District of MONMOUTH Parish of YARLINGTON Land District of MONMOUTH Lot 1 on Plan 155146

Derivation: Part of 845A-2R-0Ps & 1,550 Acres Gtd to W

Brodribb

Prior CT 47586/2

SCHEDULE 1

N191574 TRANSFER to MATHEW THOMAS LEE and MEGAN ANN LEE Registered 15-Jun-2024 at 12.01 PM

SCHEDULE 2

Reservations and conditions in the Crown Grant if any

SP 51736 BENEFITING EASEMENT: Right of Carriageway over the Right of Way 6.00 wide on P.155146

B572477 Transfer Burdening Easement: Water Pipeline Easement (Appurtenant to C/Ts 47586/3 & 4,51736/1) over the Pipeline Easement 1.00 wide shown on P.47586 as passing through Lot 2 thereon.

Portion of the Pipeline Easement 1.00 wide has been extinguished in consequence of the acquisition of the servient land pursuant to Application C441624

C892424 BURDENING EASEMENT: a pipeline easement in favour of Hobart Regional Water Authority over the land marked Pipeline Easement 10.00 wide on Plan 155146 Registered 27-Jul-2009 at 12.01 PM

E357857 MORTGAGE to Heritage and People's Choice Ltd Registered 15-Jun-2024 at 12.02 PM

UNREGISTERED DEALINGS AND NOTATIONS

No unregistered dealings or other notations



FOLIO PLAN

RECORDER OF TITLES



Issued Pursuant to the Land Titles Act 1980

PLAN OF TITLE

FOLIO REFERENCE C.T. 47586/2

OWNER D.C. & J.M. HOLMES

GRANTEE

LOCATION

LAND DISTRICT OF MONMOUTH PARISH OF YARLINGTON

REGISTERED NUMBER

P155146

PART OF 845A-2R-0P & 1550AC 2 5 FED 2009 FIRST SURVEY PLAN No. APPROVED GRANTED TO WILLIAM BRODRIBB COMPILED BY LESTER FRANKS SURVEY & GEOGRAPHIC PTY LTD Hice LENGTHS IN METRES Recorder of Titles MAPSHEET MUNICIPAL CODE No. 125 (5227) ALL EXISTING SURVEY NUMBERS TO BE CROSS REFERENCED ON THIS PLAN LAST PLAN No. P47586 LAST UPL No. FXY48 BALANCE PLAN MIDE 90.01 ROAD (2/305LO) (19/30Rly) (SP51736) RIGHT OF WAY 600 WIDE (SP51736) MAIN (P155145) CT 1 (P47586) LINE 1.266ha Inot including hatched partion (CREATED EASEMENT C892424) (P47586) TEA TREE PIPELINE -{P52810} CREATED BY 8675061 EASEMENT A LOT9 \ P155090 CROWN OWN. (P.155090) (SP121755) (SP132606) (P155147) C892425 RELEASE OF EASEMENT (P155148) PIPELINE EASEMENT 'A' 10.00 WIDE IS HEREBY RELEASED PURSUANT TO SECTION 108 LAND TITLES ACT 1980 Alice Kawa 2 7 JUL 2009 RECORDER OF TITLES DATE

Search Date: 22 Jul 2024

Search Time: 02:59 PM

Volume Number: 155146

Revision Number: 03

Page 1 of 1